


2  
A1.1  
RENOVATION FLOOR PLAN - AREA B  
1/8" = 1'-0"

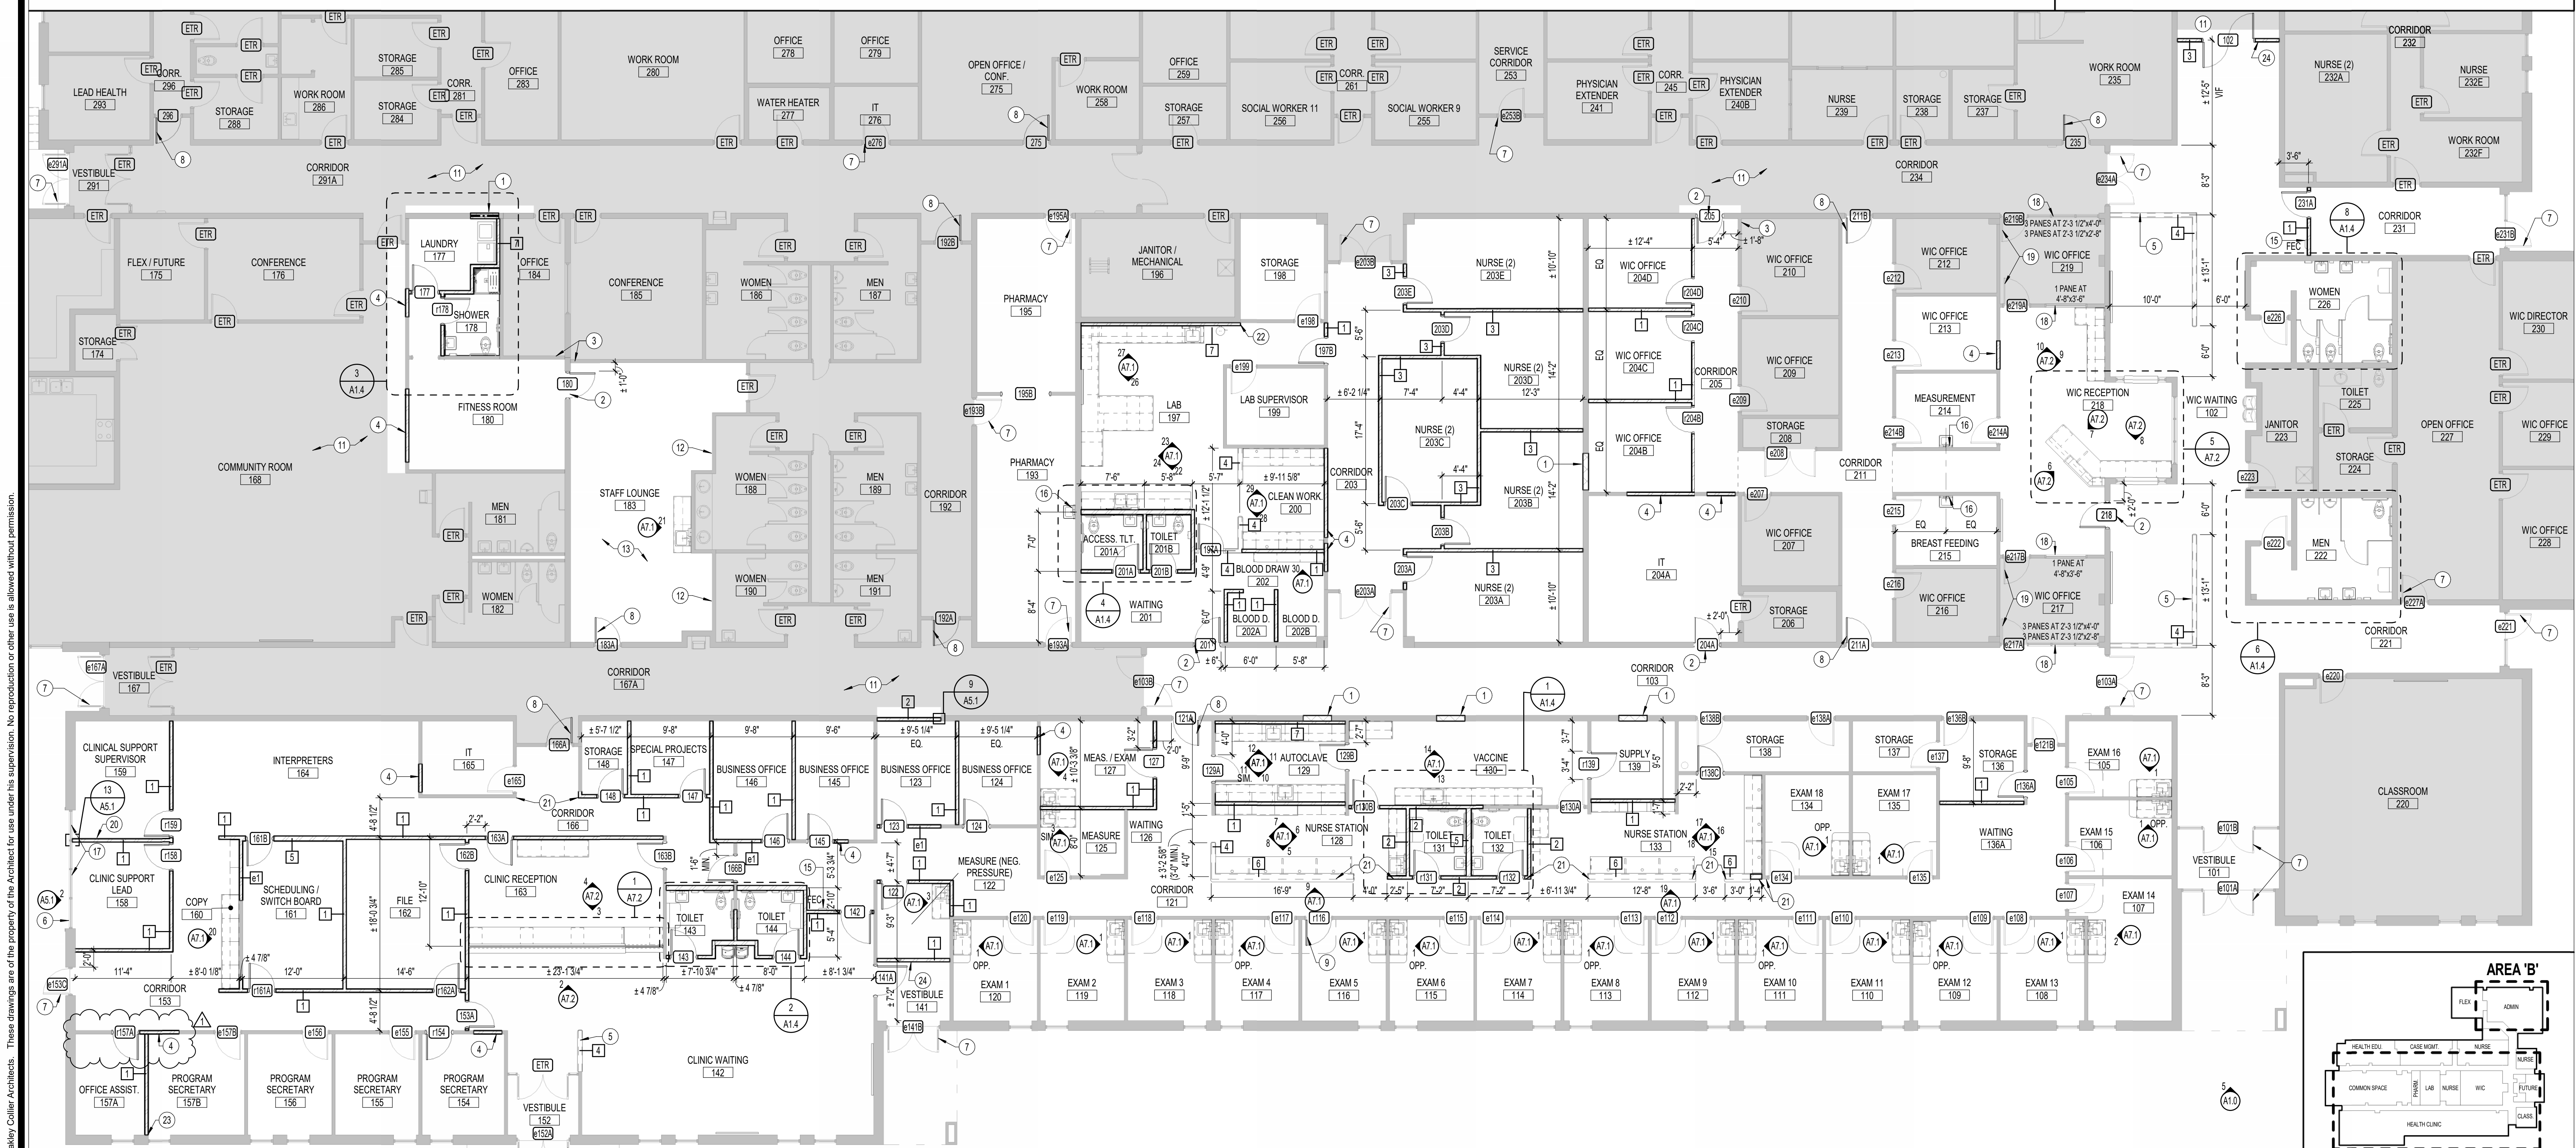

1  
A1.1  
RENOVATION FLOOR PLAN - AREA A  
1/8" = 1'-0"


- ### # KEYNOTES - FLOOR PLAN
1. INFILL OPENING IN EXISTING 8" (V/F) CMU WALL. SEE DETAIL 1/A5.1.
  2. NEW DOOR AND FRAME IN EXISTING LOAD BEARING CMU WALL. LINTEL DETAIL PER 5/A5.1.
  3. PATCH ADJACENT STUD WALL(S) AS REQUIRED AFTER INSTALLATION OF NEW LINTEL. PROTECT ADJACENT SURFACES. SEE DETAIL 5/A5.1.
  4. INFILL EXISTING OPENING IN STUD WALL. MATCH EXISTING MATERIALS.
  5. 42" H. (U.O.N.) KNEE WALL WITH ACRYLIC SOLID SURFACE TOP WITH 1" OVERHANG, TYP.
  6. REPAIR FLASHING AT LINTEL ABOVE PER DETAILS 2/A5.1 THRU 4/A5.1.
  7. EXISTING DOOR TO REMAIN. SEE DOOR SCHEDULE FOR HARDWARE MODIFICATIONS.
  8. NEW DOOR PANEL IN EXISTING FRAME. SEE DOOR SCHEDULE.
  9. RELOCATED DOOR PANEL IN EXISTING FRAME. SEE DOOR SCHEDULE.
  10. NEW WINDOW. SEE WINDOW SCHEDULE. PATCH ADJACENT MATERIALS AS REQUIRED.
  11. EXISTING FLOORING TO REMAIN. TAKE PRECAUTIONS TO PROTECT EXISTING FLOORING DURING DEMOLITION AND NEW WORK.
  12. PATCH BROKEN/MISSING VCT THIS AREA. ALLOW FOR 20 SF OF REPAIR IN BASE BID. MATCH EXISTING.
  13. STRIP AND POLISH EXISTING VCT FLOORING PER MANUFACTURER RECOMMENDATIONS.
  14. REMOVE AND REPLACE VINYL WALL COVERING AND RUBBER BASE FROM CORNER TO CORNER OR CORNER TO CLOSEST ADJACENT DOOR FRAME AS INDICATED, THIS SIDE OF WALL AS REQUIRED FOR NEW WORK. MATCH EXISTING.
  15. NEW SEMI RECESSED FIRE EXTINGUISHER CABINET PER DETAIL 8/A5.1.
  16. PROVIDE SOAP DISPENSER (SD) & FOLDED PAPER TOWEL DISPENSER (PTI) ABOVE SINK. SEE SHEET A1.4 FOR MOUNTING HEIGHTS.
  17. PROVIDE NEW HORIZONTAL BLINDS THIS STOREFRONT.
  18. PROVIDE NEW HORIZONTAL BLINDS BETWEEN MULLIONS AT EXISTING HOLLOW METAL WINDOW. FIELD VERIFY WINDOW SIZE. NO BLINDS REQUIRED ABOVE 7' AFF.
  19. PROVIDE NEW HORIZONTAL BLINDS AT HALF GLASS DOOR.
  20. CENTER WALL ON STOREFRONT MULLION.
  21. ALIGN FINISHED FACE OF WALLS.
  22. ALIGN END OF PLUMBING CHASE WALL WITH EDGE OF EXISTING GYPSUM BOARD FINISHED STUD WALL.
  23. ALIGN FACE OF WALL WITH EDGE OF MASONRY OPENING.
  24. ALIGN NEW WALL WITH EXISTING BULKHEAD ABOVE. MODIFY BULKHEAD AS REQUIRED TO SECURE NEW STUD WALL AND FOR FLUSH APPEARANCE BELOW FINISHED CEILING.

### WALL LEGEND

SCALE 1" = 1'-0"

INTERIOR: NON-LOAD BEARING 3 5/8" METAL STUD WALL			INTERIOR: 3 5/8" CHASE OR FURRED WALL		
MARK	PLAN VIEW	REMARKS	MARK	PLAN VIEW	REMARKS
1		TOP OF WALL = 4" ABOVE HIGHEST ADJACENT CEILING	7		TOP OF WALL = TO 4" ABOVE HIGHEST ADJACENT CEILING
2		TOP OF WALL = TIGHT TO BOTTOM OF DECK			5/8" TYPE X GYPSUM BOARD, FULL HEIGHT ON ROOM INTERIOR SIDE
3		TOP OF WALL = TO UNDERSIDE OF CEILING OR BULKHEAD			3 5/8" 20 GA. STEEL STUDS AT 16" O.C. WITH HORIZONTAL BRIDGING AT 48" O.C.
4		TOP OF WALL = KNEEWALL. SEE INTERIOR ELEVATION OR PLAN FOR HEIGHT.			80 ONLY - R-20 BATT INSULATION, FULL HEIGHT (NOT REQUIRED AT WALL TYPE 4)
		5/8" TYPE X GYPSUM BOARD, FULL HEIGHT EACH SIDE			
		3 5/8" 20 GA. STEEL STUDS AT 16" O.C. WITH HORIZONTAL BRIDGING AT 48" O.C.			
		SOUND BATT INSULATION, FULL HEIGHT (NOT REQUIRED AT WALL TYPE 4)			
INTERIOR: NON-LOAD BEARING 6" METAL STUD WALL					
MARK	PLAN VIEW	REMARKS			
5		TOP OF WALL = TIGHT TO BOTTOM OF DECK			
6		TOP OF WALL = KNEEWALL. SEE INTERIOR ELEVATIONS OR PLAN FOR HEIGHT.			
		5/8" TYPE X GYPSUM BOARD, FULL HEIGHT EACH SIDE			
		6" 20 GA. STEEL STUDS AT 16" O.C. WITH HORIZONTAL BRIDGING AT 48" O.C.			
		6" SOUND BATT INSULATION, FULL HEIGHT			

- ### GENERAL FLOOR PLAN NOTES
- A. DIMENSIONS ON THIS PLAN ARE FROM FACE OF EXISTING FINISHES AND CENTERLINE OF NEW OF INTERIOR STUD WALLS.
  - B. PROVIDE BRACING BACK TO STRUCTURE FOR INTERIOR WALLS, TYPICAL.
  - C. ALL DRYWALL SHALL BE 5/8" AND SHALL EXTEND 4" MINIMUM ABOVE FINISH CEILING (U.O.N.).
  - D. INSTALL SOUND ATTENUATION BATT INSULATION FULL HEIGHT IN ALL INTERIOR STUD FRAMED WALLS.
  - E. VERIFY ALL DIMENSIONS AND SIZES PRIOR TO CONSTRUCTION.
  - F. SCHEDULE AND COORDINATE ALL INSPECTIONS REQUIRED.
  - G. OBTAIN ALL PERMITS REQUIRED.
  - H. COORDINATE ALL SCHEDULES WITH THE OWNER PRIOR TO CONSTRUCTION.
  - I. SEE DOOR AND WINDOW SCHEDULES FOR ALL DOOR AND WINDOW SIZES.

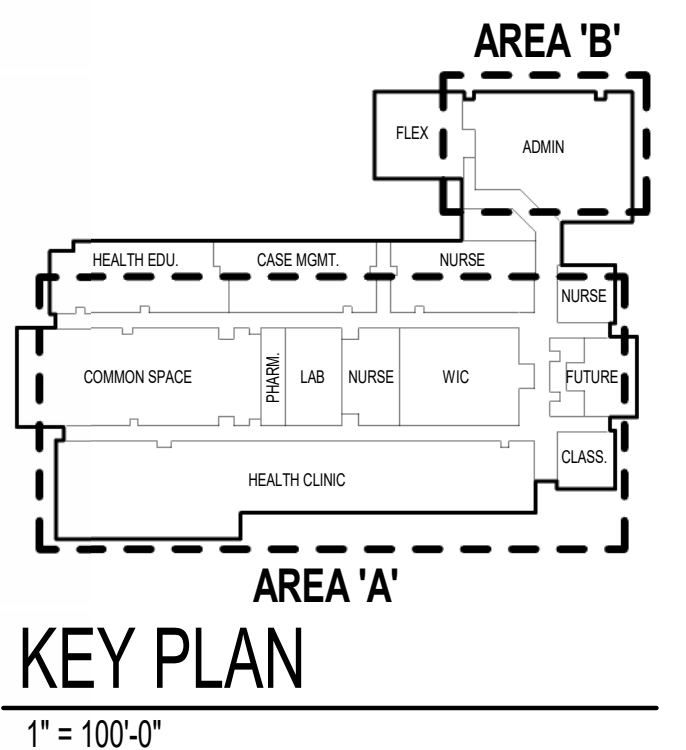

**OAKLEY COLIER ARCHITECTS**

107 Condover Road, Rocky Mount, NC 27857 (704) 252-9357 / 252-9357

255 W. Main Street, Raleigh, NC 27601

**NASH COUNTY MEDPARK BUILDING**

NASH COUNTY HEALTH DEPARTMENT

500 NASH MEDICAL ARTS MALL, ROCKY MOUNT, NC 27804

REVISIONS FOR:

CERT. NO. 50681

RD SET

RD SET

GENERAL NOTE:

Prior to construction start, Contractor shall verify & be responsible for all dimensions.

Revisions	Description	Date
1	ADDENDUM 1	06.16.25

Date	Project No.
06.04.25	23048A

Drawn By	Sheet No.
JS	A1.1

Checked By	Sheet Title
AC	RENOVATION FLOOR PLANS